



PAVEMENT/BERM DETAIL

SCALE: 1/2" = 1'

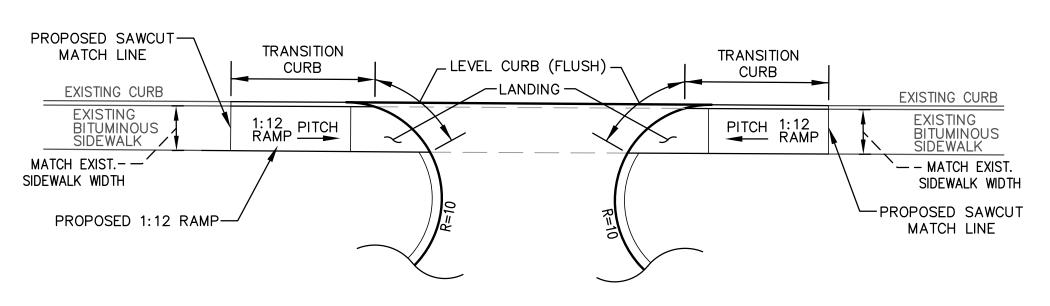

CURB CUT ENTRANCE / SIDEWALK RAMP DETAIL

NOT TO SCALE

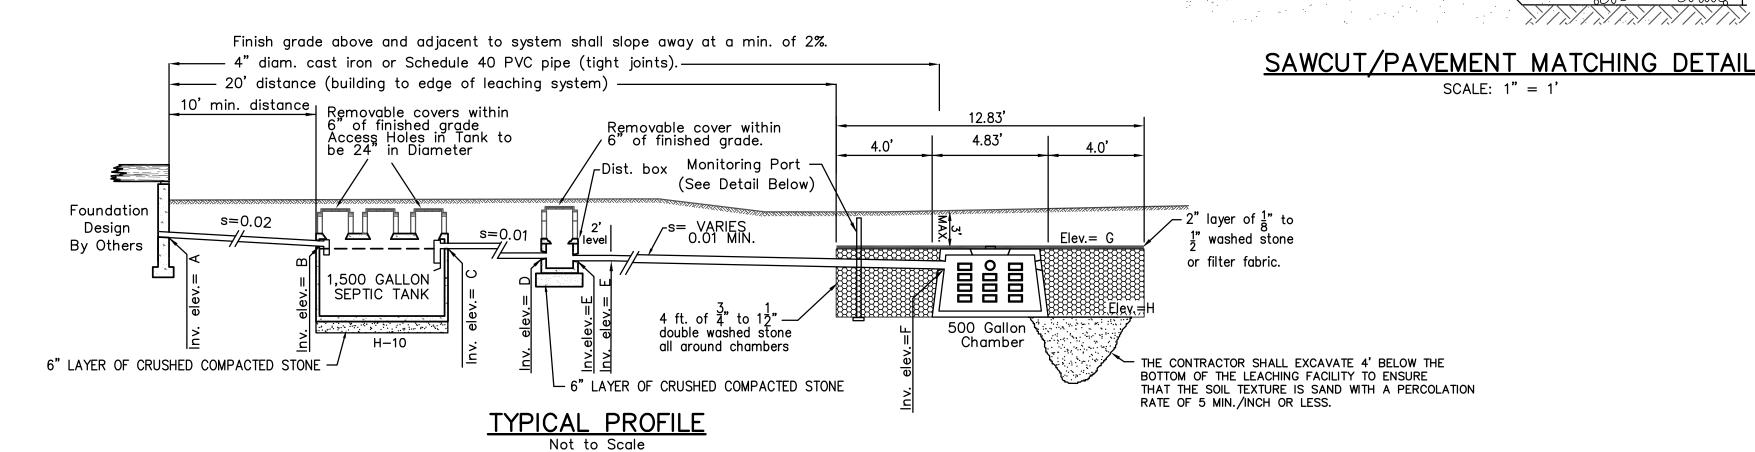

(STRUCTURES, STÒNES, BOULDERS, Friable single grain, loose 10% Gravel

	DE	EP OBS	ERVATION HC	LE LOG NO	. 2 LOT 1	
DEPTH	ELEV.	SOIL HORIZON	SOIL TEXTURE (USDA)	SOIL COLOR (Munsell)	SOIL MOTTLING	OTHER (STRUCTURES, STONES, BOULDERS, CONSISTENCY, % GRAVEL)
0"	34.7					
0"-12"	33.7	O/A	SANDY LOAM	10 YR 3/3		
12"-43"	31.1	В	SANDY LOAM	10 YR 5/6		Friable
43"-120"	24.7	С	COARSE SAND	2.5 Y 5/4	NONE	single grain, loose 10% Gravel
NO GROUNDWATER ENCOUNTERED						

DEEP OBSERVATION HOLE LOG NO. 1 LOT 1

SOIL COLOR

(Munsell)

10 YR 3/3

10 YR 5/6

2.5 Y 5/4

MOTTLING

NONE

SOIL TEXTURE

(USDA)

SANDY LOAM

SANDY LOAM

COARSE SAND

DEPTH

0"-10"

10"-37"

37"-120"

ELEV.

34.5

33.7

31.4

24.5

NO GROUNDWATER ENCOUNTERED

HORIZON

O/A

	DEI	EP OBS	ERVATION HO	LE LOG NO	. 3 LOT 2	2
DEPTH	ELEV.	SOIL HORIZON	SOIL TEXTURE (USDA)	SOIL COLOR (Munsell)	SOIL MOTTLING	OTHER (STRUCTURES, STONES, BOULDERS, CONSISTENCY, % GRAVEL)
0"	34.0					
0"-12"	33.0	O/A	SANDY LOAM	10 YR 3/3		
12"-38"	30.8	В	SANDY LOAM	10 YR 5/6		Friable
38"-120"	24.0	С	COARSE SAND	2.5 Y 5/4	NONE	single grain, loose 10% Gravel
NO GROUNE	WATER EN	COUNTERED				

CROSS COUNTRY

FERTILIZE, SEED, LIME,

AND MULCH.

EXISTING GROUND

SCREENED GRAVEL
OR CRUSHED STONE
THOROUGHLY COMPACTED

AS DESCRIBED IN THE

SPECIFICATIONS

SURFACE

PAVED STREETS

PAVING AND SUB-BASE

1" WATER SERVICE

SCALE: 1" = 1'

DOMESTIC WATER SERVICE TRENCH SECTION

NOT TO SCALE

SAWCUT EXISTING —

EXISTING PAVED SURFACE

PAVEMENT AND

MATCH GRADE

SECTION DETAIL

AS SHOWN ON PAVEMENT

GRAVEL

— SAW CUT AND PROVIDE INFRARED SEAL WHERE PAVEMENT IS IN AN EXISTING

ORDINARY BORROW, MAXIMUM _STONE SIZE 6". COMPACT IN 12" LIFTS WITH MECHANICAL TAMPER

WHERE ROAD IS GRAVEL REPLACE

- 4" BITUMINOUS CONCRETE

-1 1/2" SURFACE COURSE

-2 1/2" BINDER COURSE

BITUMINOUS CONCRETE PAVEMENT WITH GRAVEL SURFACE

UNDER ALL PAVED AREAS.

BASE COURSE

8" MIN. COMPACTED

	DE	EP OBSI	ERVATION HO	LE LOG NO	. 4 LOT 2	2
DEPTH	ELEV.	SOIL HORIZON	SOIL TEXTURE (USDA)	SOIL COLOR (Munsell)	SOIL MOTTLING	OTHER (STRUCTURES, STONES, BOULDERS, CONSISTENCY, % GRAVEL)
0"	34.5					
0"-12"	33.5	O/A	SANDY LOAM	10 YR 3/3		
12"-42"	31.0	В	SANDY LOAM	10 YR 5/6		Friable
42"-120"	24.5	С	COARSE SAND	2.5 Y 5/4	NONE	single grain, loose 10% Gravel
NO GROUNE	WATER EN	NCOUNTERED				

LEBARON MODEL LF-244 FRAME AND GRATE OR APPROVED EQUAL. BRICKS TO BE USED FOR GRADE ADJUSTMENTS. 22"±1" FRAME TO BE SET IN A SQUARE C.O. FULL BED OF MORTAR. - NON-SHRINK GROUT GAS TRAP -1" AIR HOLE-OUTSIDE DIA. OF PIPE + 2" PROVIDE "V" OPENINGS BITUMINOUS JOINT SEALANT (TYP.) MONOLITHIC BASE STEEL REINFORCED CONCRETE 4000 PSI 28 DAYS UNDISTURBED BASE

TYPICAL SOLID CATCH BASIN


SCALE: 1/2" = 1"

DESIGN CRITERIA (PER DWELLING)


Number of bedrooms 3 Equivalent to 330 gal.'s/day Garbage disposal unit: NO Leaching area — capacity required: 330 gal.'s/day Side area proposed: 92 sq. ft. Bottom area proposed: 425 sq. ft. Total area proposed: 517 sq. ft. Proposed leaching capacity: 383 gal.'s/day Water supply: TOWN Precast concrete units: H-10 & H-20 loading design

SOIL TEST

Date of soil test: 7/2/13Test taken by: L. CARREIRO Results witnessed by: S. McGANN Percolation rate: 5 MIN./IN. (IN SAND LAYER) Ground water NONE ENCOUNTERED

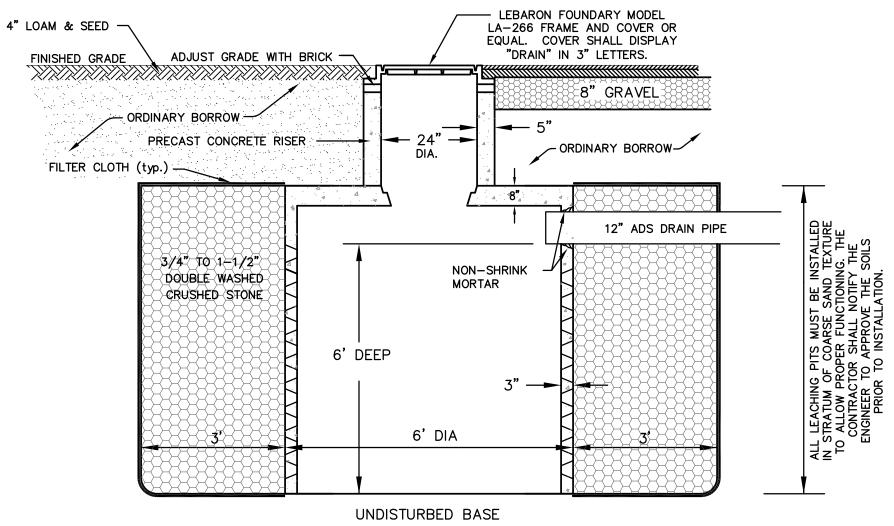

TYPICAL LEACHING PIT SCALE: 1/2" = 1'

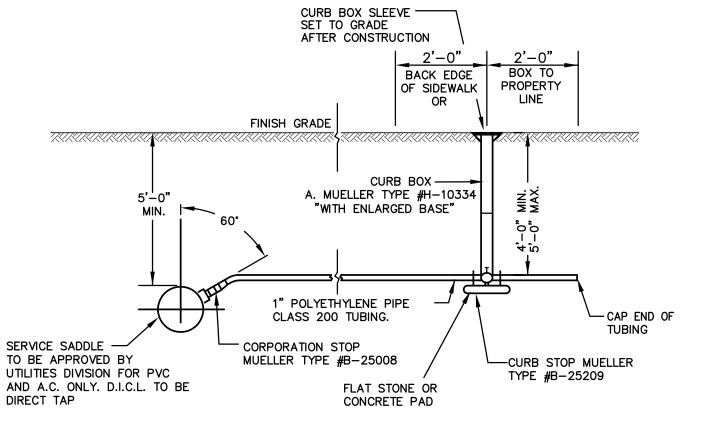

- A. BACKFILL SHALL BE NATIVE MATERIAL COMPACTED TO A DENSITY OF NOT LESS THAN 90% RELATIVE COMPACTION.
- B. SPECIAL ATTENTION MUST BE GIVEN TO BACKFILL AROUND WATER MAIN AND UNDER SERVICE PIPE.

1" WATER SERVICE INSTALLATION

Unless and until such time as the original (red) stamp of the responsible Professional Engineer, or Professional Land Surveyor appears on this plan: (A) no person or persons, including any municipal or other public officials, may rely upon the information contained herein; and (B) this plan remains the property of Holmes & McGrath, Inc.

	DATE	D	ESCRIPTION	Drawn Checked		
		R E	VISIONS			
	CONSTRUCTION DETAILS					
ER IRES, ULDERS, % GRAVEL)	SITE PLAN PREPARED FOR					
	FALMOUTH HOUSING TRUST					
e n, loose avel	TEATIC	KET	FALMOUTH	MA		
	SCALE:	1"=20'	DATE: JULY 16, 2013			
	grath, inc. d surveyors (508) 548–3564(PHONE) (508) 548–9672(FAX)					
	DRAWN	:LAC	CHECKED:			
F\FALHOUSE\209128\dwg\213089SP.dwg	JOB NO): 213089	DWG. NO.: 87-4-30B	SHEET 4 OF 4		

DEEP OBSERVATION HOLE LOG NO. 6 LOT 3 SOIL SOIL TEXTURE SOIL COLOR (STRUCTURES, STONES, BOULDERS, DEPTH ELEV. HORIZON (USDA) (Munsell) MOTTLING CONSISTENCY, % GRAVEL 32.5 0"-13" 31.4 O/A SANDY LOAM 10 YR 3/3 13"-40" 29.2 SANDY LOAM 10 YR 5/6 Friable single grain, loose 10% Gravel 40"-120" 22.5 COARSE SAND 2.5 Y 5/4 NONE

DEEP OBSERVATION HOLE LOG NO. 5 LOT 3

SOIL COLOR

10 YR 3/3

10 YR 5/6

2.5 Y 5/4

(Munsell)

(STRUCTURES,

STONES, BOULDERS,

Friable

single grain, loose 10% Gravel

MOTTLING

SOIL TEXTURE

(USDA)

SANDY LOAM

SANDY LOAM

COARSE SAND

SOIL

HORIZON

O/A

C1

ELEV.

32.5

31.4

29.3

22.5

NO GROUNDWATER ENCOUNTERED

NO GROUNDWATER ENCOUNTERED

DEPTH

0"-13"

13"-39"

39"-120"